

NOTES: For plan details refer to LMA drawing no. 500.

ROOF CONSTRUCTION:

Gutters to be plastisol faced galvanised steel hi-line type with matching 100mm square downpipes.

FINISHES:

STORE / WORKSHOP

FLOOR: concrete to be coated with safety coat epoxy resin containing fine particles embedded in the tough epoxy resin coating enhancing safety and traction with chemical and wear resistant properties.

SKIRTINGS: epoxy - safety coat paint to be taken up wall to continue protection and act as dust sealer, exact height to be confirmed on site to suite blockwork level (1 course) min 150mm.

WALLS: new fair faced blockwork walls to be painted with a cleanable / wearing paint finish. engineering brickwork to external leaf at low level, external finish to be rendered system.

CEILING: exposed inner face of insulated composite profiled roof panel.

TANK STORE

FLOOR: concrete floor slab with brushed finish and towelled edge margin.

SKIRTINGS: n/a

<u>WALLS</u>: open area to main elevation, 2 sides of area to have open bladed louvres for full height.

CEILING: n/a

FITTINGS:

STORE / WORKSHOP

1no. emergency drench shower to be fitted externally

1no. externally mounted fire hose to be provided adjacent to entrance gates.

SIGNAGE:

Signage to be provided to the building which indicates:

- A. Liquid Oxygen
 B. Oxidising Substance
 C. No Smoking
 D. No Naked Lights
 E. No Storage of Oil/ Grease or combustable materials
 F. Extreme Colid Hazard
 G. Authorised Persons Only
 H. No Mobile Phones
 J. No Steel Tipped Shoes/ Boots.

PRELIMINARY

P1	Preliminary issue of drawing	3	NW N	05 10 09 0
	Step to that or bonding added, debte instituted freton ended	2	W	09 08 10
P3	Alterations following MOD comments sent 23/7/13 Step to rear of building added, ducts indicated, notes added	¥	MM	06 00 43



British Lines LOx Store Gibraltar

Ground Floor & Roof Plan as Proposed

	Checked By	Date
RS	RS	03/18/10
Job No.	Sheet No.	Rev.
08-49	200	(P3)
	Job No.	RS RS Job No. Sheet No.



Ridge Level

A 4750
B 3250
C 2750
D 2750
E 2750
F Condition
From Level

A 1750
F Condition

FRONT ELEVATION

TOWN PLANNING AND BUILDING CONTROL


18 MAR 2014

Roof: Kingspan ks1000rw SS single sheet roof cladding system; metal box gutters and downpipes


Walls: Store/Workshop: Fair faced blockwork walls external finish to be render system. Tank Store: open area to main elevation, 2 sides of area to have open bladed louvres for full height.

Windows: UPVC double glazed.

RECEIVED

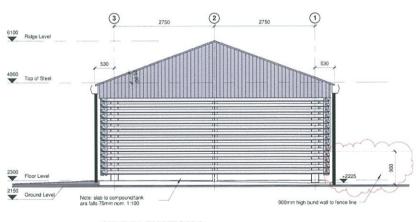

SIDE ELEVATION 2
Scale: 1:50

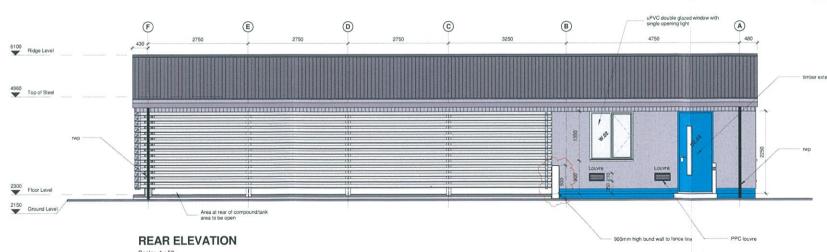

PRELIMINARY

Rev.	Revision description	Drawn	Checked	Date
P1	Preliminary issue of drawing	2	W	11.05.10
P2	Levels revised to suit new location. Colour of doors amended.	8	¥	09.08.10
P3	Alterations following MOD comments sent 23/7/13	AL	MM	05.09.13

lovelock mitche

Lovelock Mitchell Architect
3 Stanley Street Chester CH1 2L5
Tel +44 (0) 1244 40434
Fax +44 (0) 1244 40434


Project

British Lines LOx Store Gibraltar

Title

Elevations as Proposed

Scale @ A1		Checked By	Date
1:50	AJ	NM	03/18/10
	Job No.	Sheet No.	Rev.
Drawing Number	08-49	201	P3

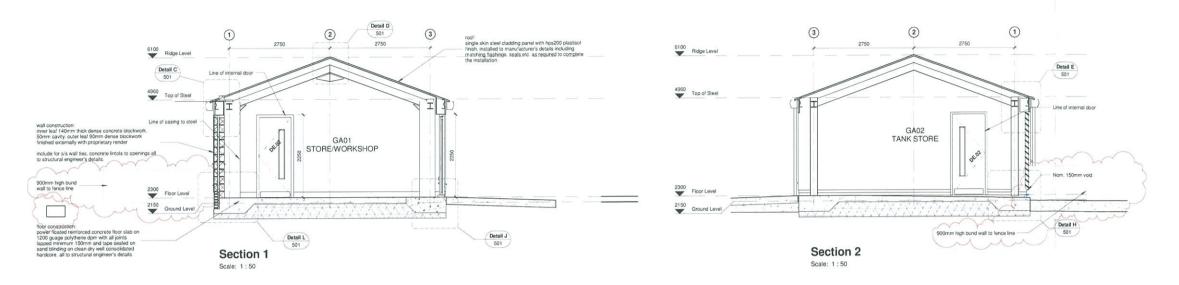

Refer to structural engineers drawing for details of all steelwork throughout

Concrete floor slabs to structural engineers details

This drawing is to be read in conjunction with the following drawing numbers:

200- G.A floor and roof plan 501 - section details - external openings - louver schedule and details

GENERAL NOTES







lovelock mitchell

Stanley Street Chester CH12LS
Tel +44 (0) 1244 404321
Fax +44 (0) 1244 404340

e-mail: admin@lovelockmitchell.c web: www.lovelockmitchell.c


Project


British Lines LOx Store Gibraltar

Title

Sections as Proposed

Scale @ A1		Checked By	Date
1:50	AJ	NM	18,03,10
	Job No.	Sheet No.	Rev.
Drawing Number	08-49	202	P3

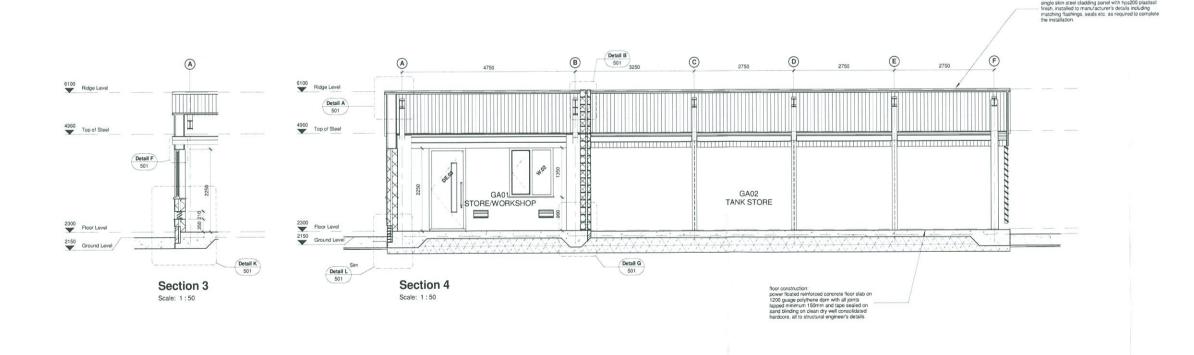

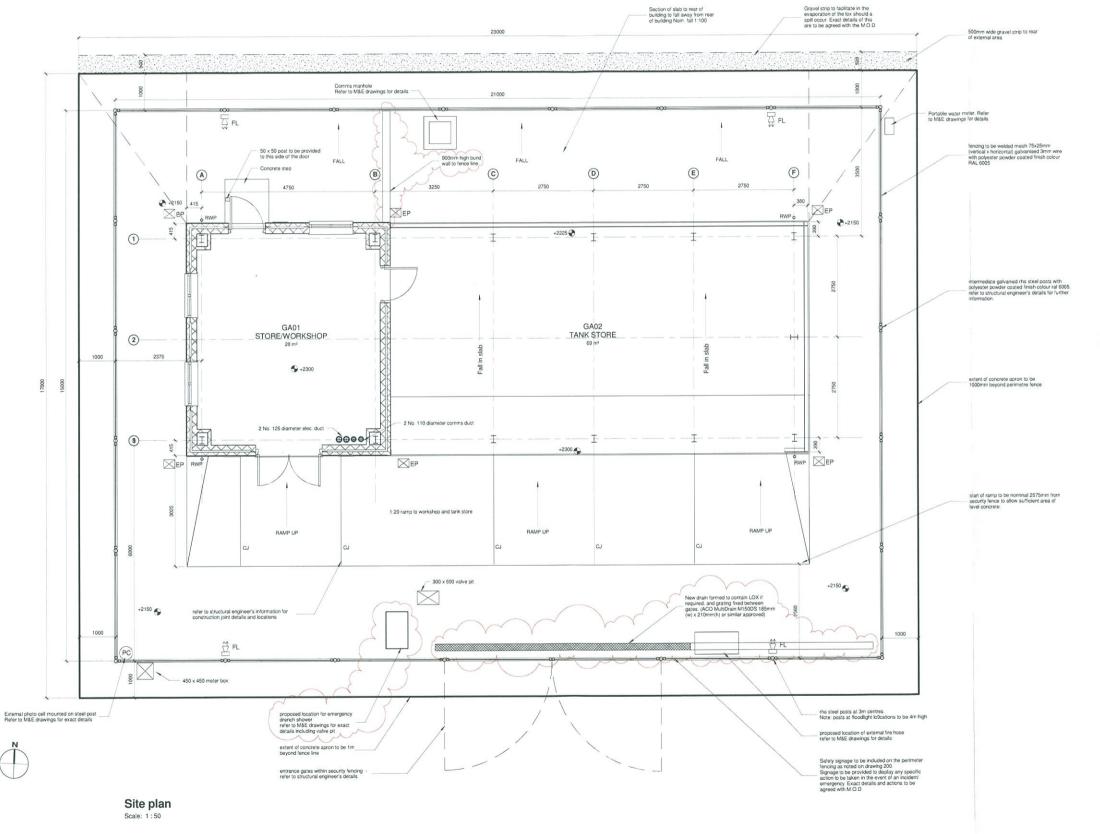

GENERAL NOTES

drawing to be used for details of external works only, drawing to be read in conjunction with associative external works contractor and structural engineers drawings for exact ramp make up, construction joint details and further information, refer to structural engineers drawings for further details.

security fencing:

class 2 anti-intruder fencing to consist of galvanised rhs steel posts with polyester powder coated finish colour real 6005. steel posts to be 2900mm high and at 3000mm centres, end posts being 80 x 80 x 3mm rhs with intermediate posts 60 x 60 x 3mm rhs. for further details of posts, fixing and foundations refer to structrial engineers details. fencing to be welded mesh 75 x 25mm (vertical x horizontal) galvanised 3mm wire with polyester powder coated finish colour ral 6005. for further details refer to structural engineers details, fencing to include 3 strands of barbed wire at 200mm centres at top of fencing.



EP Earthing pit refer to M&E drawings for details

FL External flood lights on 4m high post refer to M&E drawings for details

TOWN PLANNING AND **BUILDING CONTROL**

18 MAR 2014

RECEIVED

PRELIMINARY

P3	Alterations following MOD comments sent 23/7/13	AL	MM	09 09 13
P2	levels revised to suit new locations, step to rear door added. Gravel strip incorporated to rear of slab. Portable water meter and comma marhole indicated, post indicated to side of door, valve pit repositioned.	3	NM	05.00.10
P1	Preliminary issue of drawing	2	MM	11 05 10
Rev.	Revision description	Drawn	Checked	Date





British Lines LOx Store Gibraltar


1.50 1 2 3 4 5m

External Works

Scale @ A1		Checked By	Date
1:50	RS	NM	26.03.10
	Job No.	Sheet No.	Rev.
Drawing Number	08-49	101	(P3)

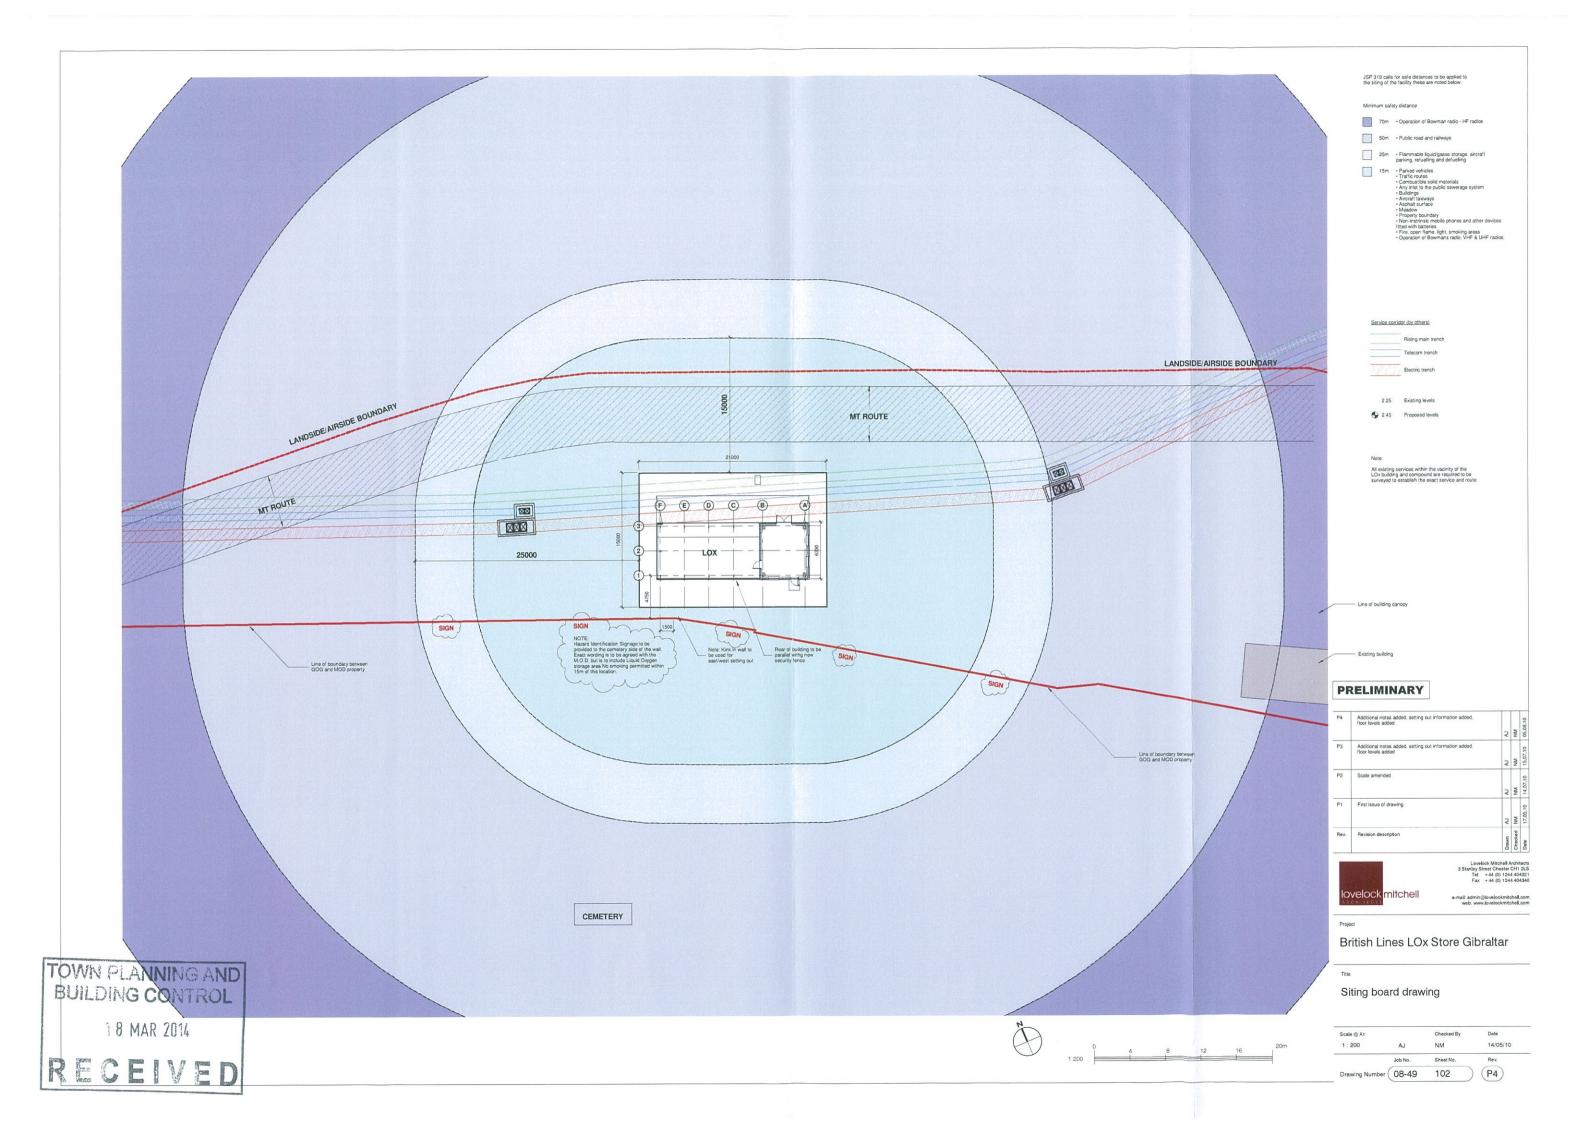

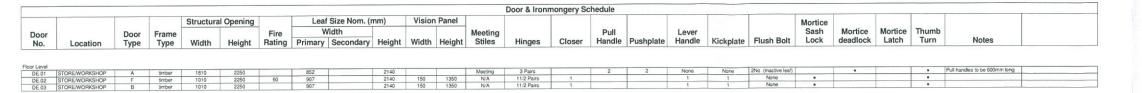


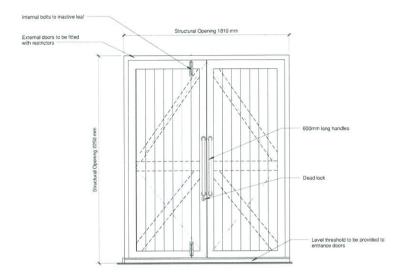

Structural Opening 1010 mm


Door Type B - External Door


- Internal Door (60mins)

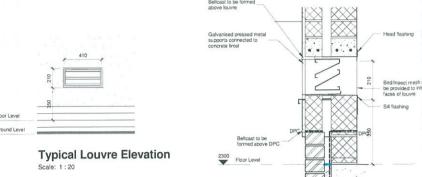

Typical Louvre Section


Door Type A - External Door

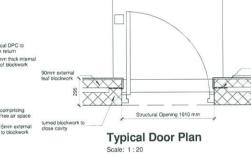


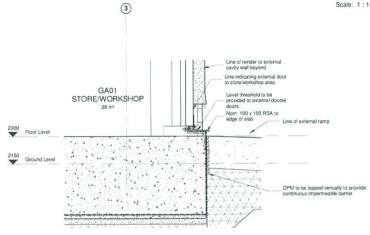

Double Door Plan

Window Schedule											
Window	Vindow Window		Structural Opening	Head	Sill	Wall	Fire				
No.	Type	Location	Width	Height	Height	Height	Thickness	kness Rating Lintel Le	Lintel Length	Frame Finish	Comments
W.01	1	STOREWORKSHOP	1200	1350	2250	900	295	N/A	1490	UPVC - White	
W.01 W.02	1	STORE/WORKSHOP STORE/WORKSHOP	1200 1200	1350 1350	2250 2250	900 900	295 295	N/A N/A	1490 1490	UPVC - White UPVC - White UPVC - White	

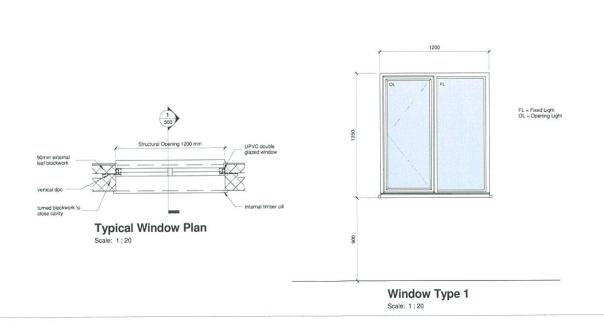

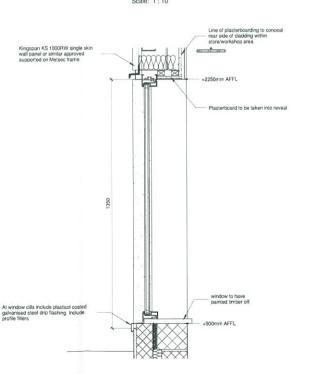

Section 8

Typical window section

EXTERNAL WINDOWS

GENERAL SPECIFICATION:

- All ironmongery to opening light windows is to be brushed stainless steel to match door ironmongery.
- 2. All opening lights are to be provided with lockable handles.
- Trickle ventilators to be designed by the window sub-contractor to provide background ventilation in accordance with Approved Document F.
- This drawing is for architectural integration purposes only, the specialist window sub-contractor shall produce workshop drawings and submit to the Architect for comment prior to manufacture.
- 6. Refer to M&E Engineers details for ventilation requirements.
- 7. Fabricator to site check openings prior to manufacture.
- To critical locations provide toughened glazing in accordance with diagram 1, Approved Document N.
- Window Sub-contractor to ensure adequate fixing detail for windows into turned block cavity details.
- 11. For details of lintels refer to Structural Engineers details.
- All glazing units are to achieve a u-valve of 1.6w/m2k. All units are to be internally beaded.

EXTERNAL DOORS

GENERAL SPECIFICATION:

- Number of hinges to external doors to the specialist sub-contractors design to suit the height and weight of the doors.
- All dimensions are approximate and subject to site check by sub-contractor prior to fabrication of door and frames.
- 4. Include anti-finger trap stiles.
- To critical locations provide toughened glazing in accordance with diagram 1, Approved Document N.
- 6. Weather bar to be included to all external doors.
- Paint finished galvanised steel guard hoops with a restraining catch will be provided to all external doors.



PRELIMINARY

P3	Levels amended to suit revised position of building			9.13
		2	2	.60.60
P2	Levels amended to suit revised location of building.	3	MM	09.08.10
P1	Preliminary issue of drawing	¥	MM	11.05.10
Rev.	Revision description	Drawn	Checked	Date



British Lines LOx Store Gibraltar

External Openings and Door & Window Details

	30D NO.	Short No.	
	Job No.	Sheet No.	Rev.
As indicated	RS	NM	03/18/10
Scale @ A1		Checked By	Date

